



SECTION 1-1 (SCALE 1:10)  
(6000MM FROM EXPANSION JOINT TO MID SPAN)

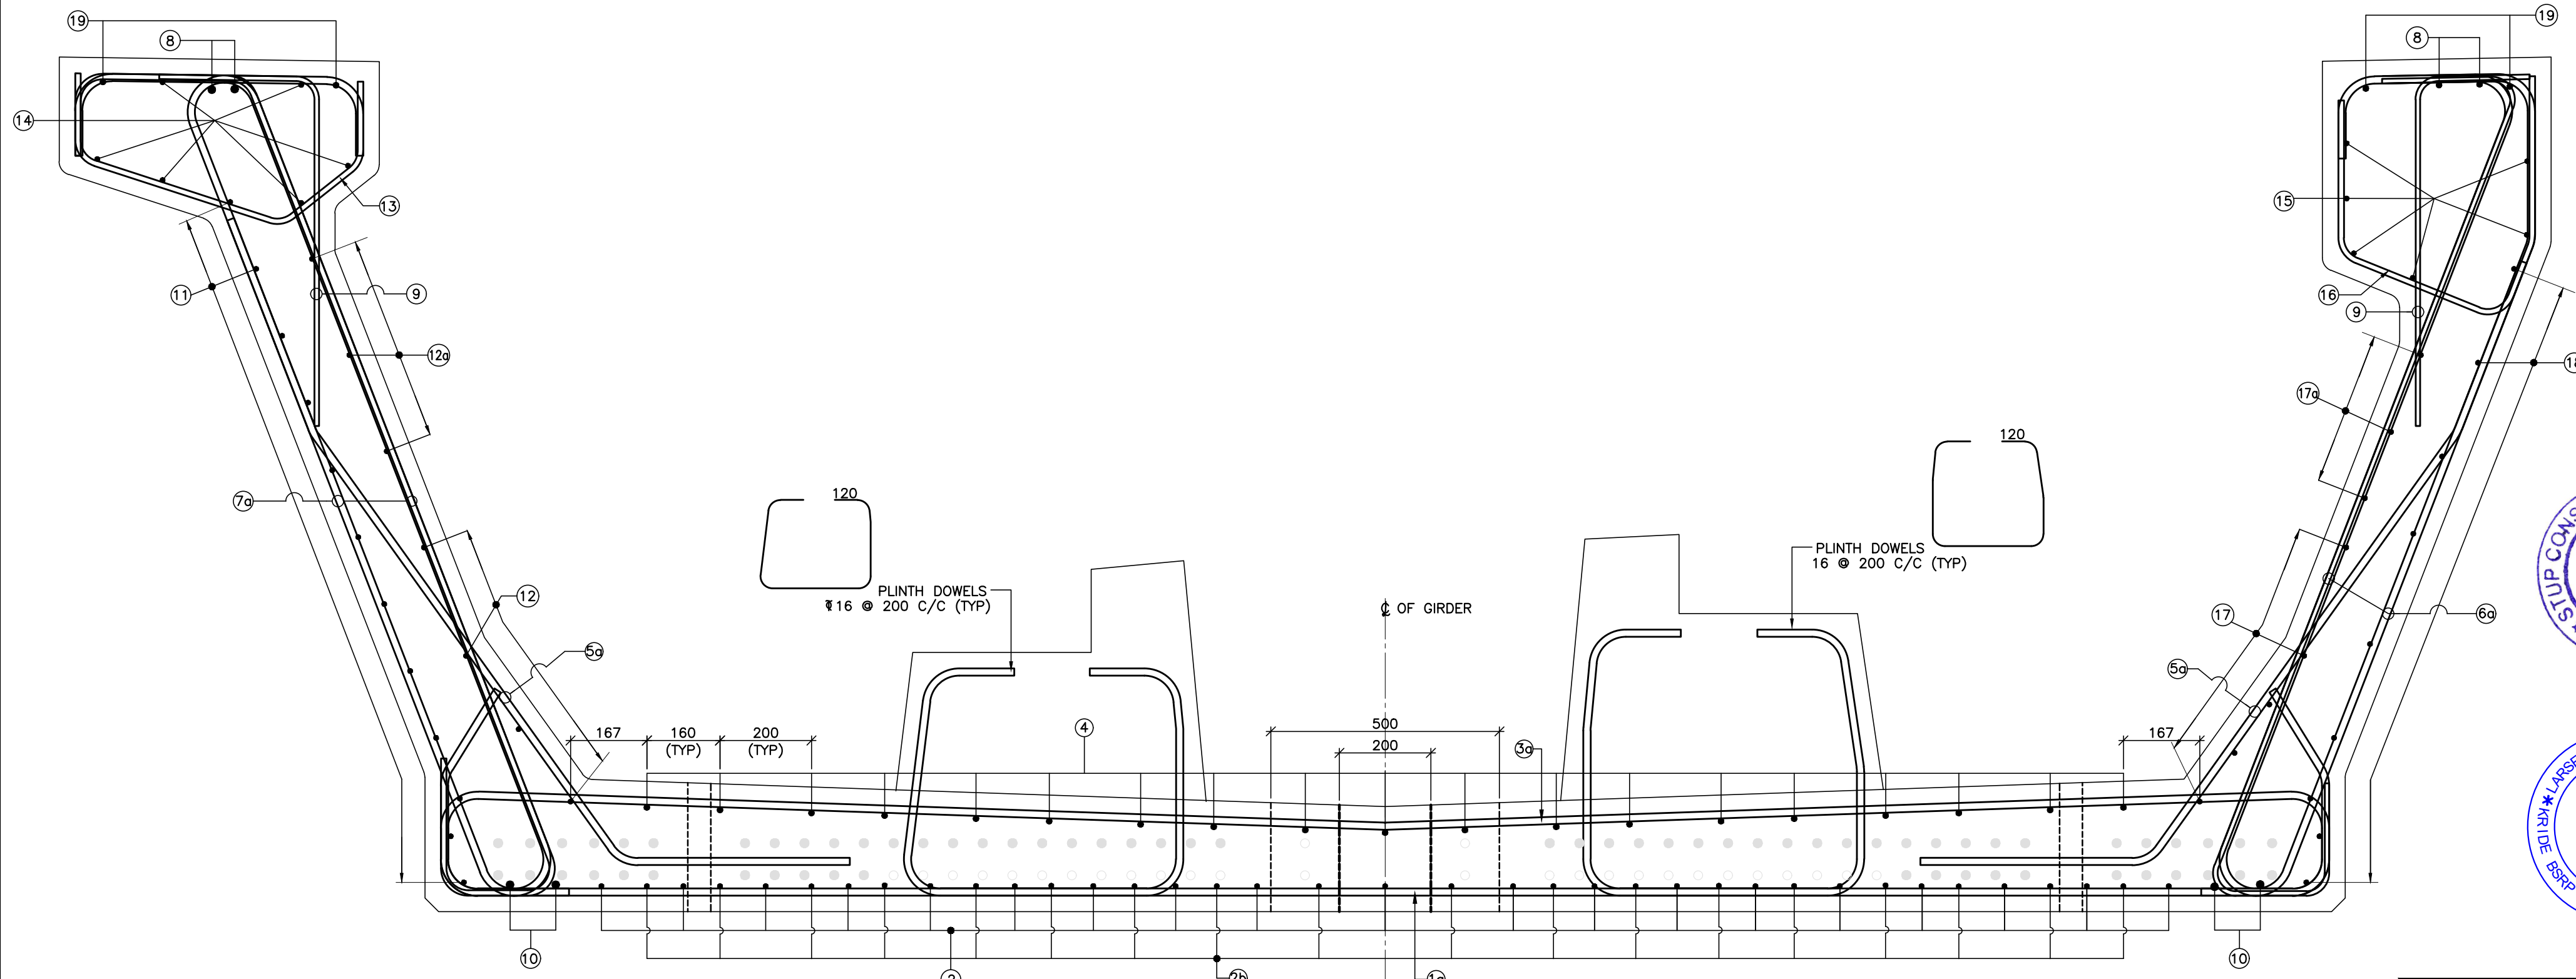

SECTION 2-2 (SCALE 1:10)  
(1000MM FROM EXPANSION JOINT TO 6000MM)

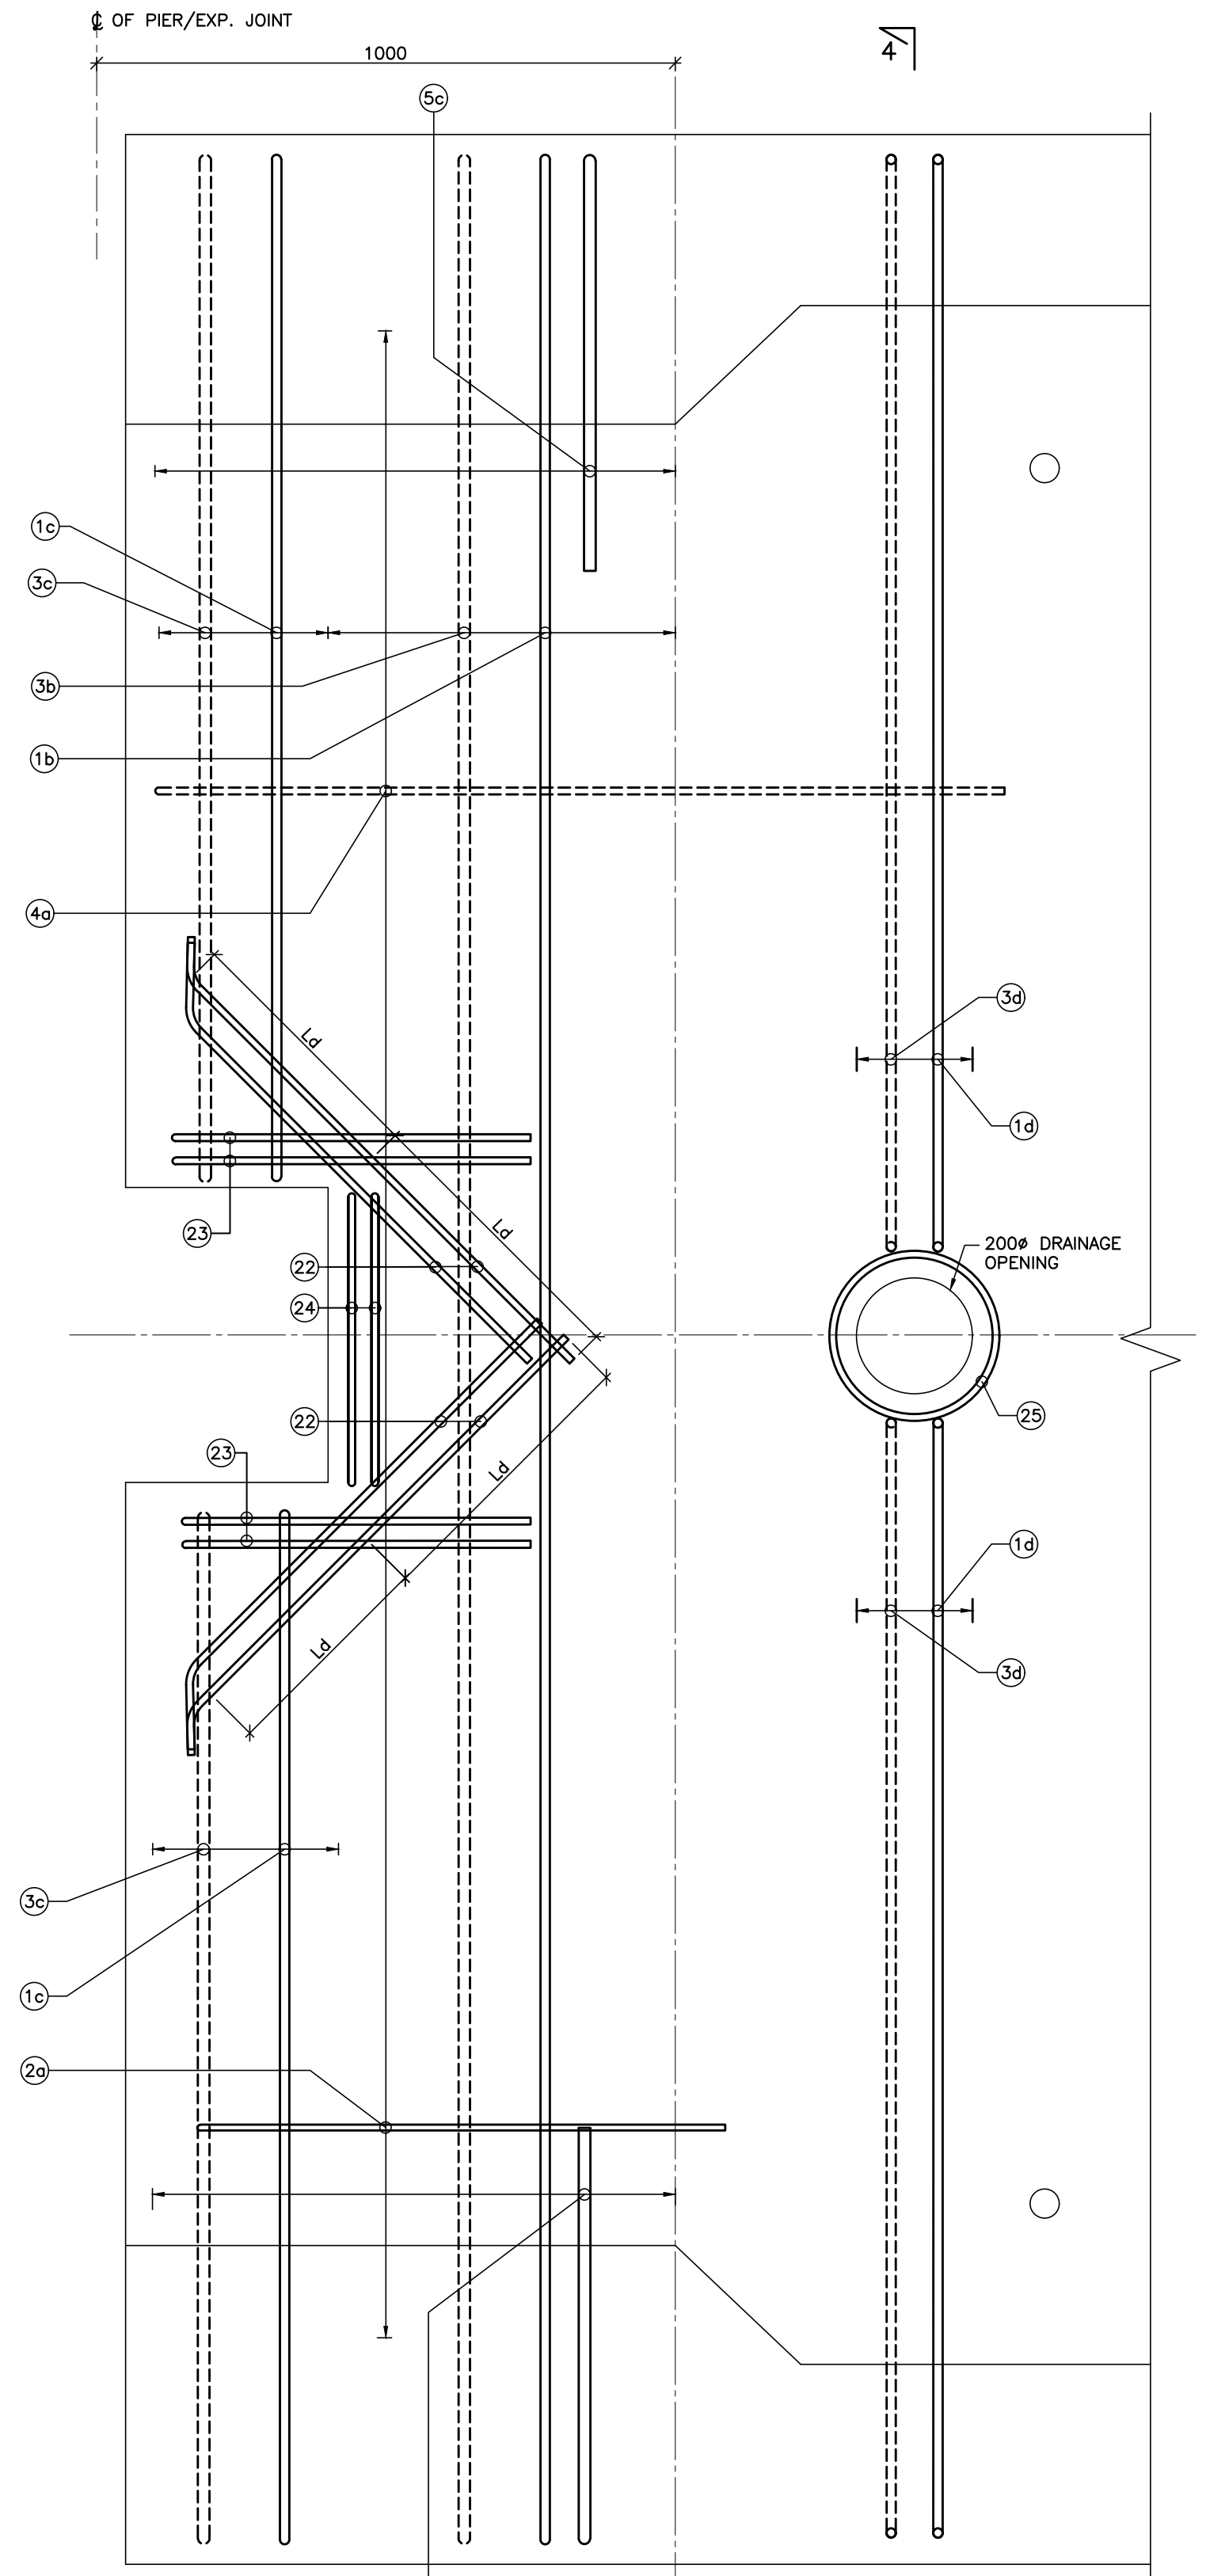

DETAIL-1 (SCALE 1:10)


NOTES :  
1. ALL DIMENSIONS ARE IN MILLIMETRES, UNLESS OTHERWISE MENTIONED.  
2. DIMENSIONS ARE NOT TO BE SCALED, FOLLOW ONLY WRITTEN DIMENSIONS.  
3. FOR OTHER NOTES REFER DRAWING 022077-BSRP-CR2-C-VD-GEN-30-1004

LEGEND :

REFERENCE DRAWINGS :

LICENSE :  
"THIS DESIGN FOR THE PROJECT HAVE BEEN PREPARED UNDER LICENSE FROM M/S SYSTRA"

KEY PLAN

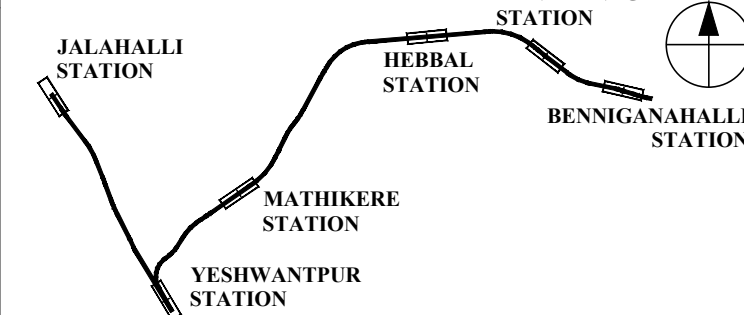




STATION BOX KEY PLAN

EMPLOYER :

DESIGNATION	NAME	SIGN

REVISIONS	
0	15.07.2024 FOR CONSTRUCTION
F	16.04.2024 REVISED BY ADDING PATENT NOTE AND DUE TO CONGESTION OF REINFORCEMENT IN SITE
E	05.01.2024 REVISED CONSIDERING FULL CDA VALUE AS PER GC'S COMMENTS TROUGH LATTER NO. 1209 ALSO REVISED DUE TO PC'S COMMENTS
D	06.10.2023 REVISED DRAWING AS DRAWING CHANGED FROM ONE DIMENSIONAL TO TWO DIMENSIONAL AND AS PER GC'S COMMENTS
C	03.07.2023 REVISED AS MARKED
B	12.12.2022 DRAWING UPDATE WITH EUDL
A	18.10.2022 FOR APPROVAL
REV	DATE
BRIEF DESCRIPTION	

CONTRACTOR :  TRANSPORTATION INFRASTRUCTURE IC EDRC-SPECIAL BRIDGES	
DETAILED DESIGN CONSULTANT (DDC) :  STUP Consultants Pvt. Ltd. 3rd & 4th Floor, Mall Road, Bangalore-560052 Tel: 080-40307979 Email: bangalore@stupsystem.com www.stupsystem.com	PROOF CONSULTANT (PC) :  Indian Institute of Technology Madras IT P.O., Chennai 600 036 INDIA

QUALITY ASSURANCE				
The responsibility of control, check and verification of accuracy, correctness, completeness, integration and full compliance of Contract provisions in respect of design analysis and drawing rests with Design & Build Contractor.				
DDC		PC	Contractor	
SIGN				
DATE	09.05.2024	09.05.2024	09.05.2024	09.05.2024
NAME	ABDULLA S	VIJAYENDRA J	SHASHIDHAR C	KVM
PREPARED BY	CHECKED BY	APPROVED BY	APPROVED BY	ISSUED BY

GENERAL CONSULTANTS	
CHECKED & APPROVED	COUNTER SIGN
NAME	SIGN
PROJECT DIRECTOR	
CIVIL/GAD	SIGN
CIVIL/ALIGNMENT	NAME
CIVIL/STRUCTURAL	DATE
CIVIL/GEOTECH	CIVIL/STRUCTURAL
	GMC/CIVIL/DESIGN

EMPLOYER :  RAIL INFRASTRUCTURE DEVELOPMENT COMPANY (KARNATAKA) LIMITED	
GENERAL CONSULTANTS :    AECOM-EGIS-WSP	

PROJECT : <b>BENGALURU SUBURBAN RAILWAY PROJECT (BSRP) K-RIDE CORRIDOR - 2</b>	
DRAWING TITLE : <b>REINFORCEMENT DETAILS OF STANDARD 31m SPAN SUPERSTRUCTURE</b>	
(SHEET 1 OF 2)	
DRAWING NO. : <b>022077-BSRP-CR2-C-VD-GEN-30-1005</b>	REVISION <b>0</b>
SCALE : AS SHOWN PRELIMINARY DWG (P), DEFINITIVE DWG (D), CONSTRUCTION DWG (C), AS BUILT DWG (B), SHOP DWG (S), MANUFACTURED DWG (M)	DWG STATUS <b>C</b>
DATE : 09.05.2024	SHEET SIZE - A1
FILENAME	A